


**3No. 33/36kV COMBINER  
PANEL FOR EVACUATION**

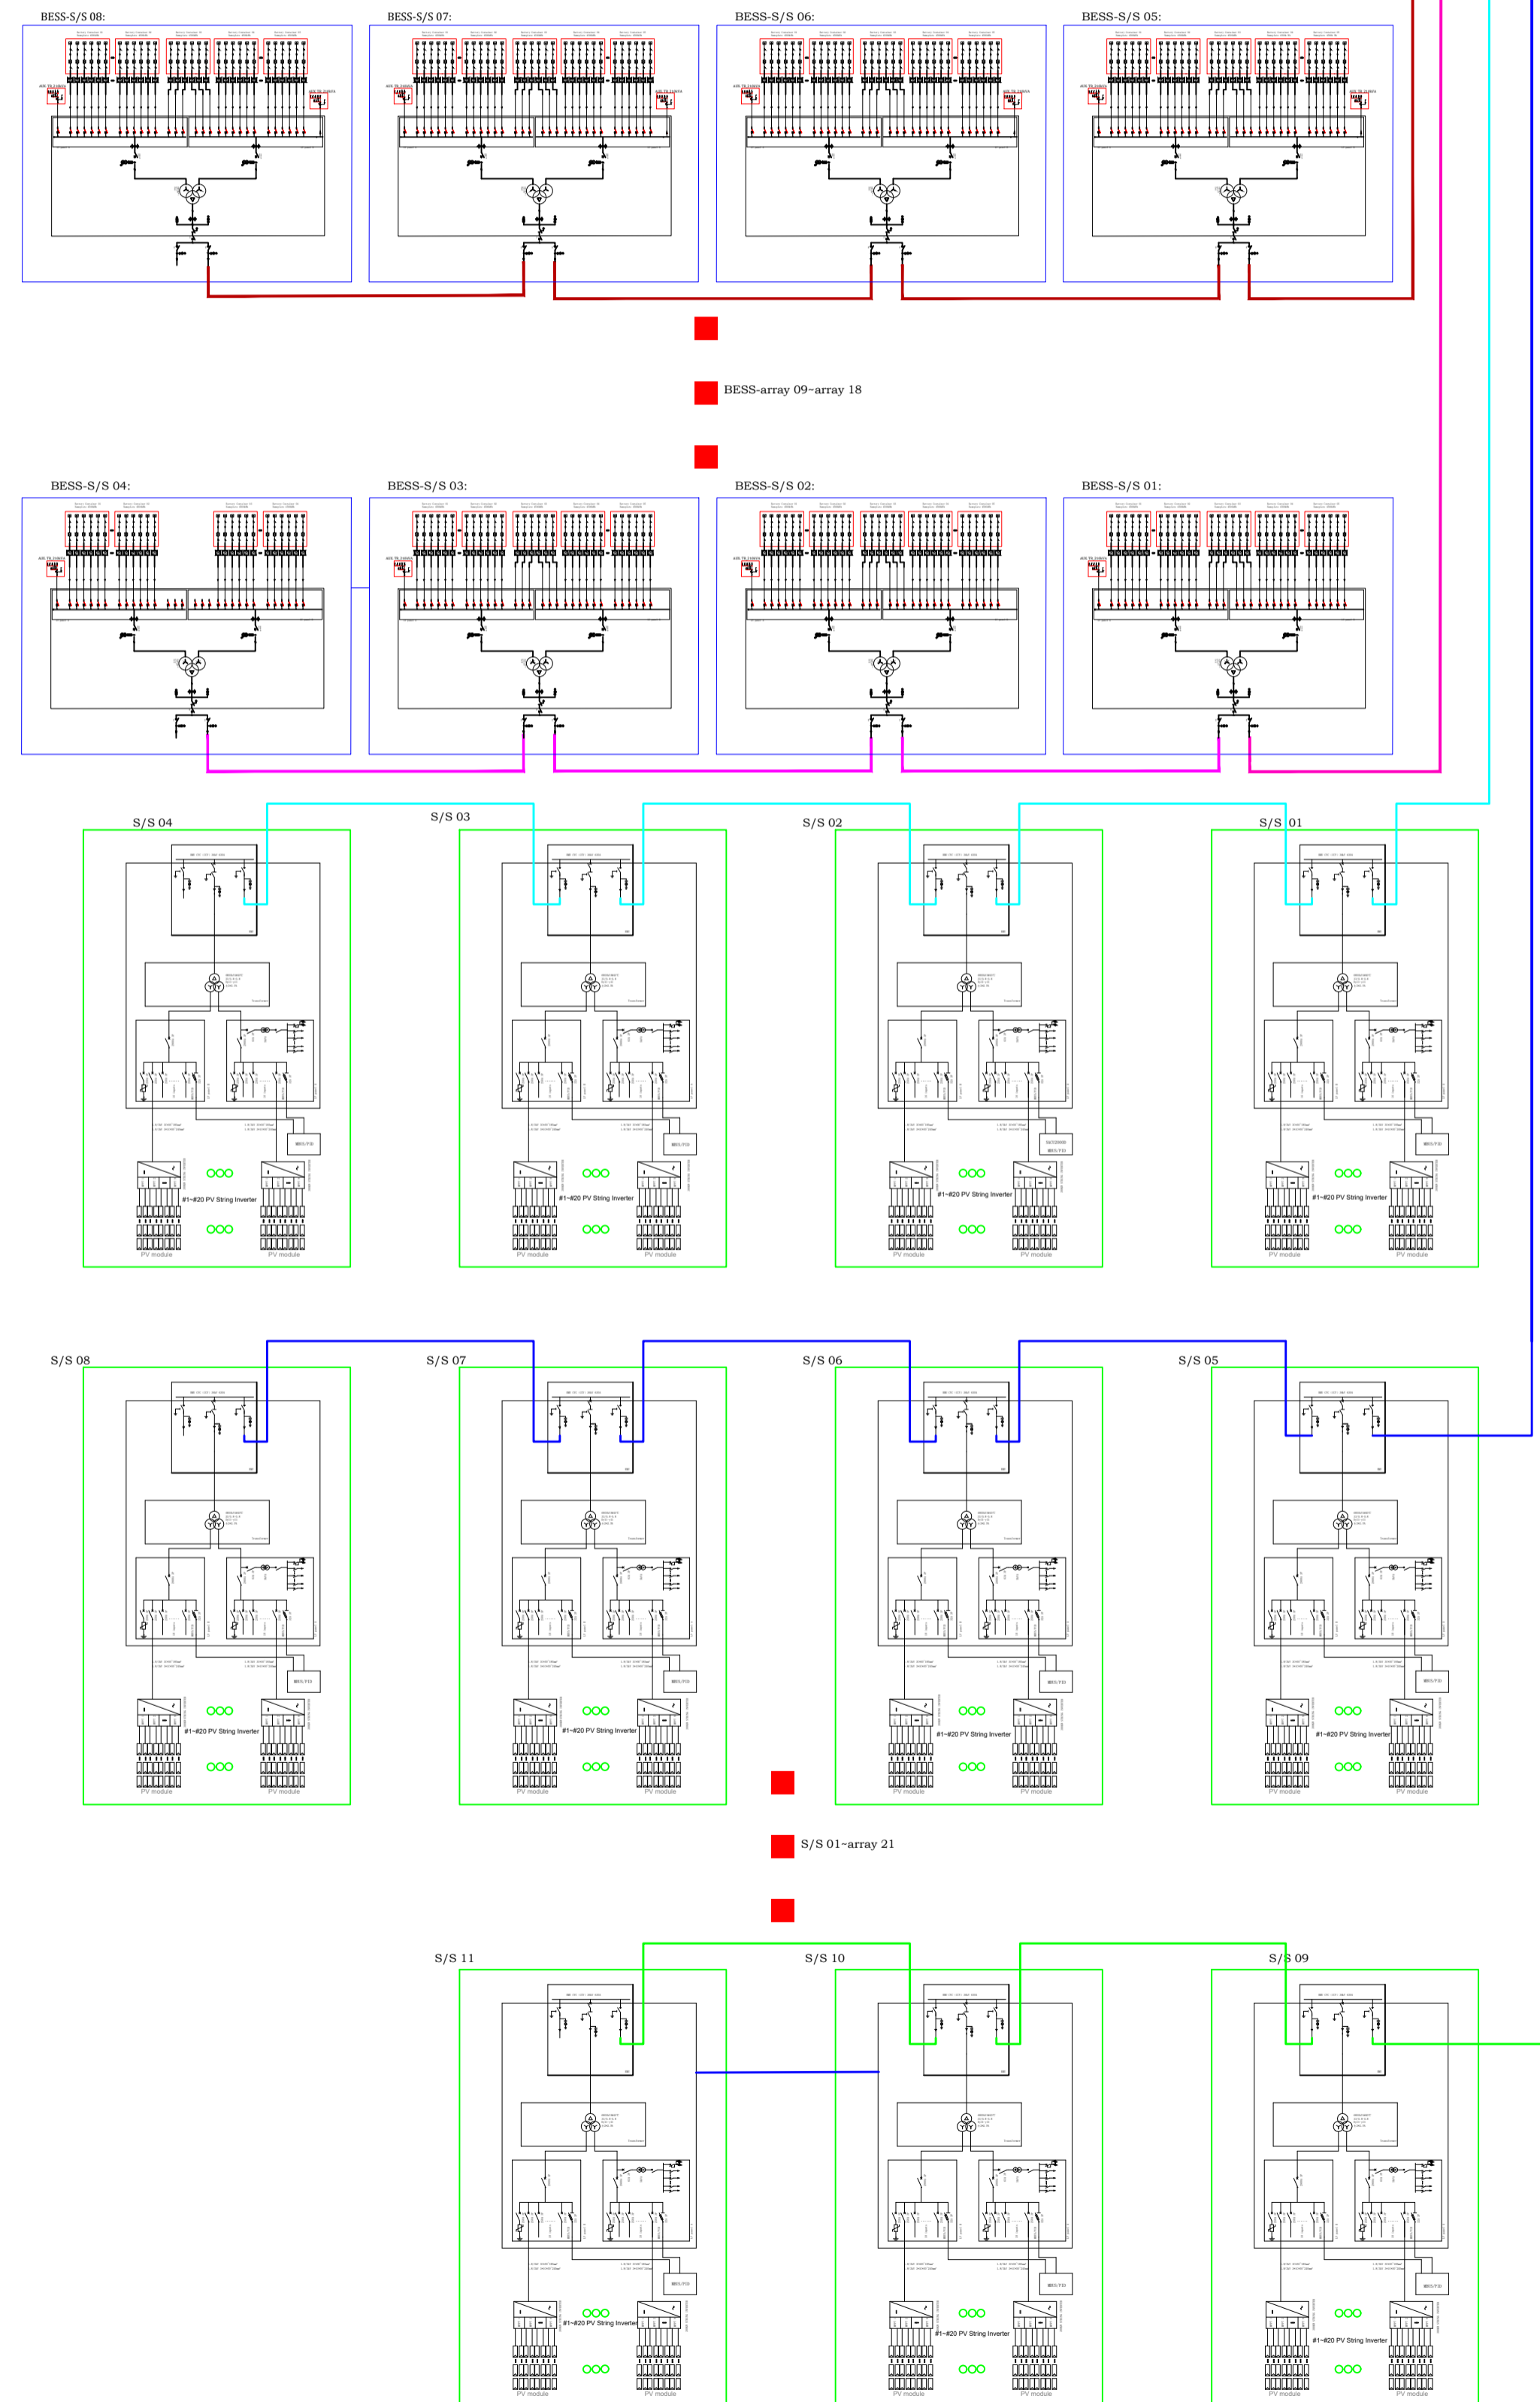

BESS BOQ For SS1	
Qty. of ESS	39
Qty. of PCS	146
Qty. of DTS	8
Qty. of SACU	8
Qty. of STS(6800K)	8

PV BOQ For SS1	
Qty. of INV.	220
Qty. of SACU	21
Qty. of STS(6800K)	11

- NOTES
1. THIS DRAWING IS TO BE READ IN CONJUNCTION WITH ALL OTHER DISCIPLINES, DRAWINGS, SCHEDULES AND SPECIFICATIONS, LEGENDS AND STANDARD DETAILS.
  2. THIS DRAWING IS COPYRIGHT AND SHALL NOT BE REPRODUCED WITHOUT PERMISSION.
  3. DIMENSIONS GOVERN ON ALL DRAWINGS AND DETAILS. SHOULD ANY DISCREPANCIES BE FOUND WITH THIS DRAWING AND ANY ASSOCIATED DRAWINGS OR SPECIFICATIONS THIS SHOULD BE BROUGHT TO THE ATTENTION OF THE H&E BUILDING SERVICES CONSULTANT IMMEDIATELY.
  4. UNLESS OTHERWISE STATED ALL DIMENSIONS ARE IN MILLIMETRES.
  5. DO NOT SCALE FROM THIS DRAWING.
  6. DIMENSIONS TO BE CHECKED ON SITE BEFORE ANY WORK IS PUT IN HAND OR PREFABRICATED.
  7. THIS DRAWING SHOULD ONLY BE USED FOR THE SPECIFIC SERVICES INTENDED.
  8. THIS DRAWING SHOWS THE DESIGN INTENT ONLY. THE CONTRACTOR SHALL BE RESPONSIBLE FOR THE FULL CO-ORDINATION OF THE SERVICES INDICATED ON THIS AND ALL OTHER SERVICES DRAWINGS.
  9. FINAL ACCESS AND SETTING OUT OF SERVICES SHALL BE AGREED BETWEEN THE ARCHITECT AND THE CONTRACTOR.
  10. THE PROJECT NOTES ARE TO BE READ IN CONJUNCTION WITH ALL RELEVANT TECHNICAL SPECIFICATIONS.

REVISIONS, ADDITIONS & ALTERATIONS			
NO	DATE	DESCRIPTION	BY

CONSULTANTS	

CLIENT	




**PROJECT**  
 PROPOSED HYBRID SOLAR  
 PV POWER PLANT WITH  
 BESS-DAYNILE POWER PLANT

**DRAWING NAME**  
 MAIN SCHEMATIC LAYOUT

**DRAWING NAME**  
 MAIN SCHEMATIC LAYOUT

PROJECT NO	A201		
DRAWING NO	SESRP/01/DPP/25		
DRAWN BY	MH	SIGN	DATE
DESIGNED BY	MH	SIGN	DATE
REVISION NO	0	SCALE 1:100@A1	

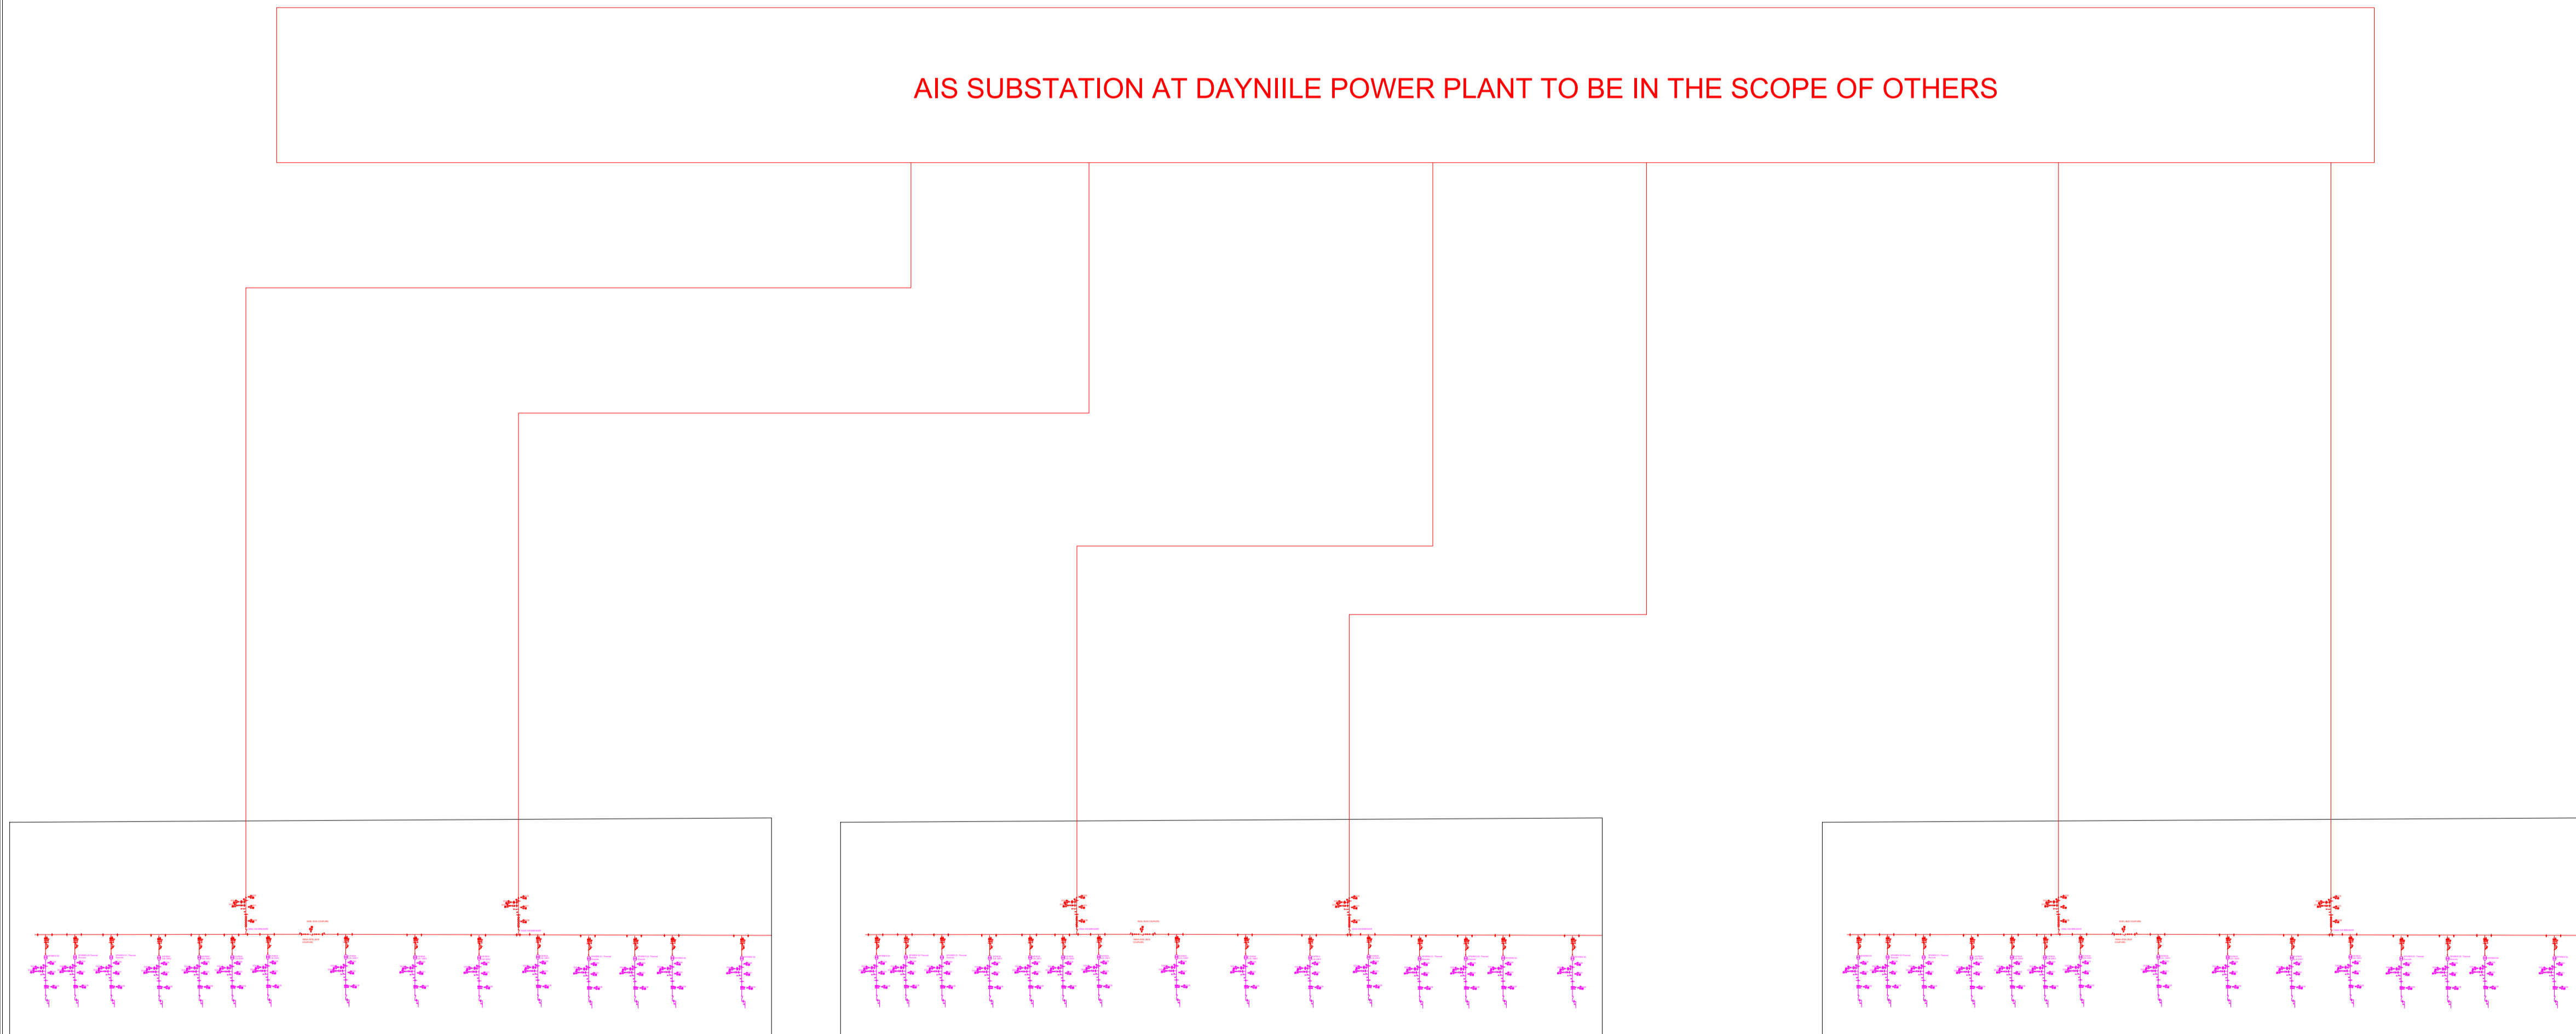

AIS SUBSTATION AT DAYNIILE POWER PLANT TO BE IN THE SCOPE OF OTHERS

PROPOSED GENERATION SUB - STATION 01 : DAYNIILE POWER PLANT

- NOTES
1. THIS DRAWING IS TO BE READ IN CONJUNCTION WITH ALL OTHER DISCIPLINES, DRAWINGS, SCHEDULES AND SPECIFICATIONS, LEGENDS AND STANDARD DETAILS.
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REVISIONS, ADDITIONS & ALTERATIONS

NO	DATE	DESCRIPTION	BY

CONSULTANTS



PROJECT  
 PROPOSED HYBRID SOLAR PV POWER PLANT WITH BESS-DAYNIILE POWER PLANT

DRAWING NAME  
 MAIN SCHEMATIC LAYOUT

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PROJECT NO	A201			
DRAWING NO	SESRP/01/DPP/25			
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